



FLOOR FRAMING NOTES:

- FLOOR SHEATHING SHALL BE 3/4" TONGUE & GROOVE APA RATED SHEATHING (48/24), NAIL @ ALL FRAMED PANEL EDGES AND OVER ALL SHEAR WALLS w/0.1130 @ 6"o.c. AND 12"o.c. TO ALL INTERMEDIATE FRAMING. PLACE LONG DIRECTION OF PLYWOOD PERPENDICULAR TO JOISTS DIRECTION, STAGGER PANEL JOINTS.
- FLOOR JOISTS SHALL BE PER PLAN AND HANGERS SHALL BE SIMPSON ITS, U.N.O.
- TYPICAL LEDGER TO BE 2x8 ATTACH TO FRAMING w/(3) 0.131" @ 16"o.c. AND (1) 1/2" @ 32" o.c.
- TYPICAL HEADER SHALL BE 4x8 DF#2.
- ALL BEAMS ARE FLUSH AND ALL HEADERS ARE DROPPED, U.N.O.
- PROVIDE (2) BEARING STUDS UNDER EACH END OF ALL BEAMS AND (1) 2x TRIMMER (BEARING) STUD AND (1) 2x KING (FULL-HEIGHT) STUD AT EACH END OF ALL HEADERS SEE7/S3.1, U.N.O. NAIL STUDS TOGETHER PER GENERAL STRUCTURAL NOTES.
- ◇ - INDICATES # OF 2x6 BEARING STUDS WHERE MORE THAN (2) REQUIRED.
- PROVIDE SOLID BEARING BELOW ALL POINT LOADS ABOVE.
- BEARING WALLS SHALL BE 2x6 HF STUDS @ 16"o.c., U.N.O. SEE SHEAR WALL, HOLDOWN AND STRAP SCHEDULES ON S3.1 FOR ADDITIONAL REQUIREMENTS AT SHEAR WALL FRAMING.
- AT BREAKS IN DOUBLE TOP PLATE OF ALL EXTERIOR WALLS AND ALL SHEAR WALLS SEE DETAIL 6/S3.1.
- SW-X INDICATES SHEAR WALL PER SCHEDULE 1/S3.1. SEE ARCHITECTURAL DRAWINGS FOR ADDITIONAL INFORMATION. ALL EXTERIOR WALLS SHALL BE SHEATHED PER SW6, U.N.O.
- ✓ - INDICATES HOLDOWN LOCATED AT ENDS OF SHEAR WALLS ABOVE, SEE HOLDOWN SCHEDULE ON 4/S3.1. SEE FOUNDATION PLAN FOR ANCHOR BOLT CALL-OUTS.
- REFER TO GENERAL STRUCTURAL NOTES FOR ADDITIONAL REQUIREMENTS.

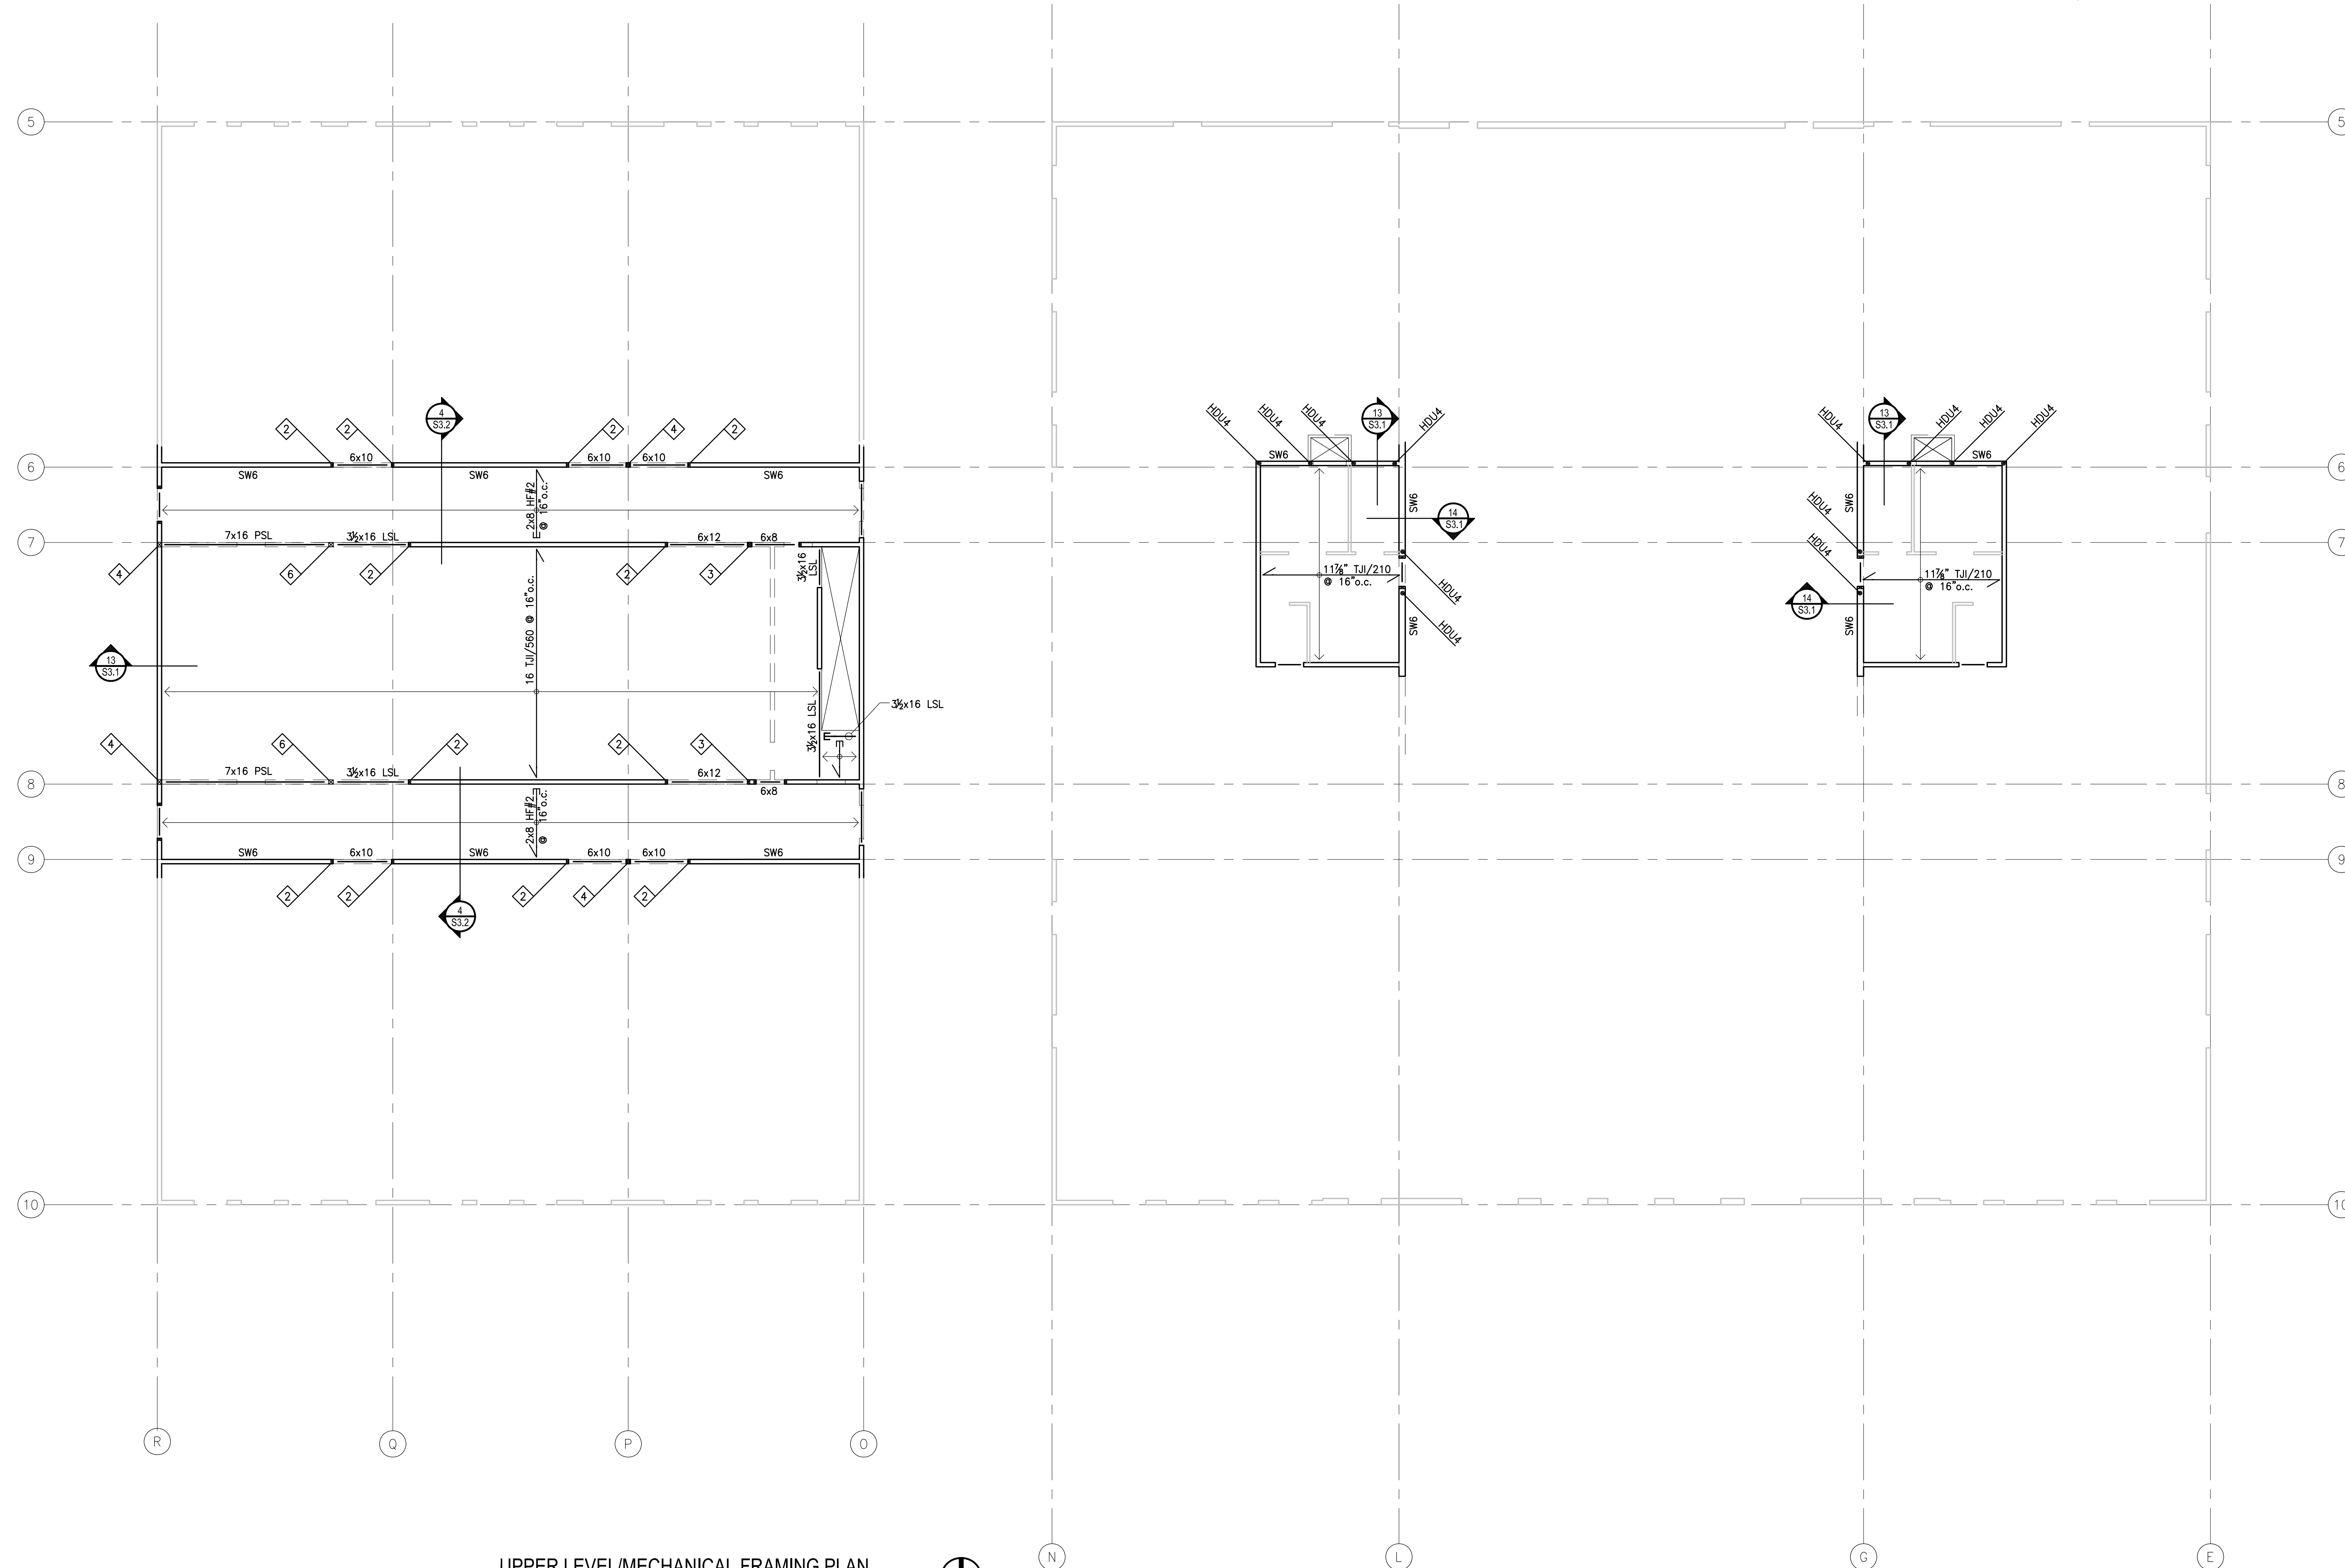

UPPER LEVEL/MECHANICAL FRAMING PLAN
SCALE = 1/8" = 1'-0"

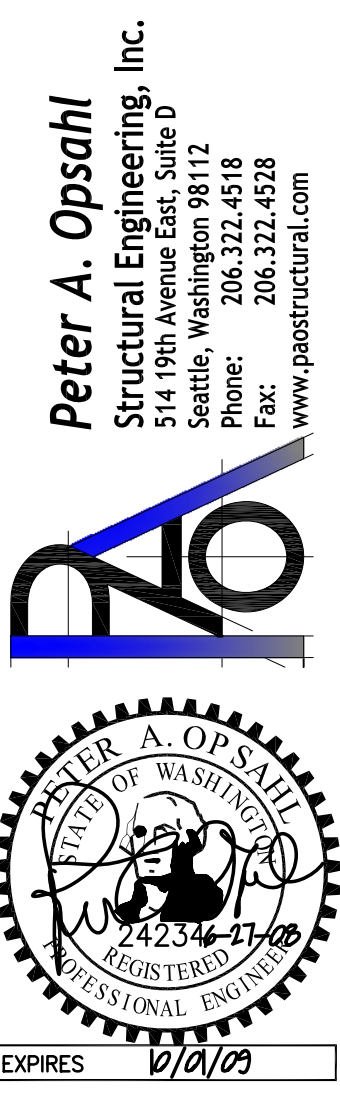

Copyright © 2008
These drawings are pending copyright and may not be reproduced or redrawn without written permission. Use of these drawings are limited to a specific project for persons named. Any other use or reuse is strictly prohibited without written consent from Jeff Dalquist.

PROJECT & LOCATION
CEDAR RIVER ACADEMY
ENUMCLAW, WA ~ KING COUNTY

SHEET CONTENTS
UPPER LEVEL / MECHANICAL FRAMING PLAN

DATE & REVISIONS
04/13/08 SCHEMATIC DESIGN
04/27/08 PERMIT SET

SHEET NUMBER
S2.2
PERMIT SET